


MBCI "ECO-FICIENT" CLASSIC WALL PANELS (R-21.4) OR EQUAL, 3" THICK BY 42" WIDE BY FULL HEIGHT PANELS W/ TONGUE AND GROOVE CONCEALED FASTENING, 26 GA. EXTERIOR PANEL AND 26 GA. INTERIOR LINER PANEL. PREFINISHED KYMAR COLOR, SELECTED FROM FULL RANGE.

ATAS INTERNATIONAL, INC. "OPALINE" OPM 045 PANEL 440 ALUMINUM, 3/4" THICK BY 41/2" HIGH PANEL BY FULL LENGTH, CONCEALED FASTENING. PREFINISHED KYMAR SELECTED FROM FULL RANGE.

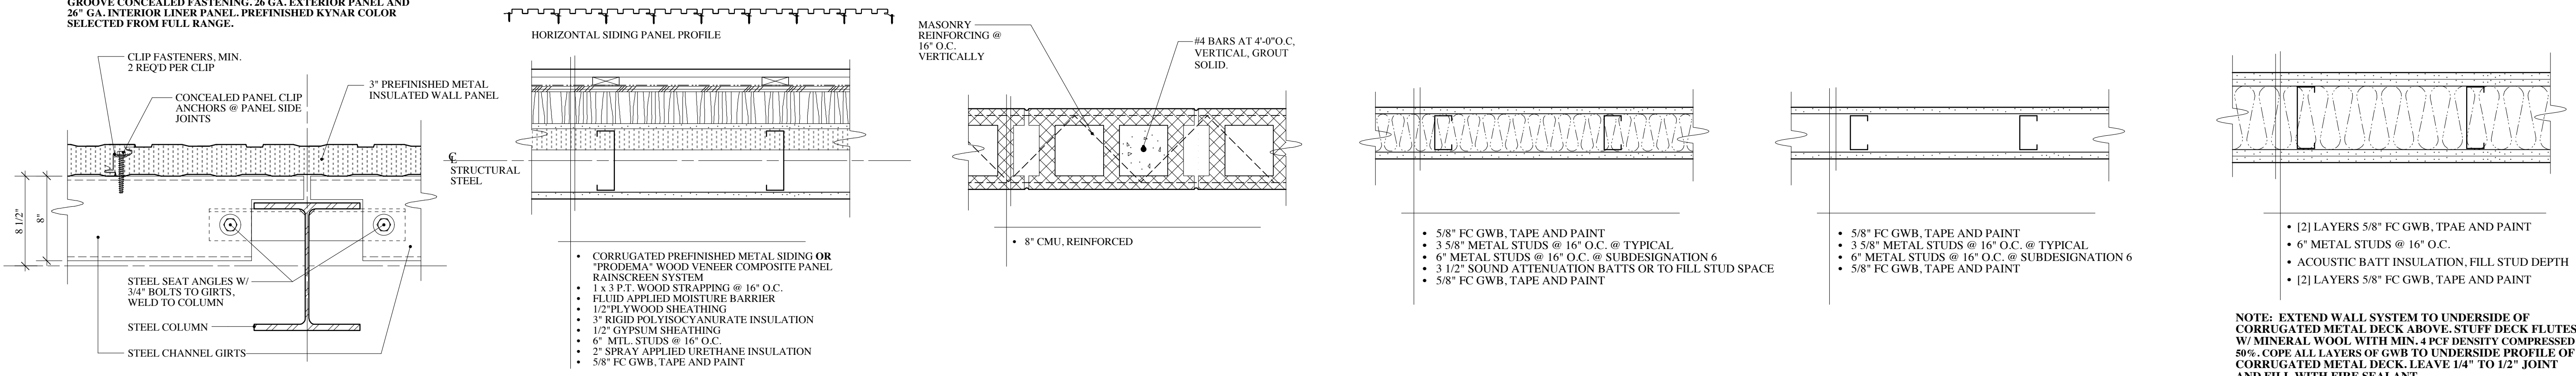

1 INSULATED PREFINISHED METAL WALL PANEL 1 1/2" = 1'-0"
 2 EXTERIOR WALL • ADMIN. WING 1 1/2" = 1'-0"
 3 CMU WALL 1 1/2" = 1'-0"
 4 ACOUSTIC GWB PARTITION 1 1/2" = 1'-0"
 5 GWB PARTITION 1 1/2" = 1'-0"
 6 2 HOUR FIRE SEPARATION PARTITION (U403) 1 1/2" = 1'-0"

GROSS AREA SUMMARY

GARAGE	10,508 SF
ADMIN.	1,052 SF
MEZZANINE	430 SF
TOTAL GROSS AREA	11,990 SF

TYPICAL DRAWING NOTES

- THE CONTRACTOR IS RESPONSIBLE FOR VERIFYING ALL DIMENSIONS IN THE FIELD AND WILL PROMPTLY NOTIFY THE ARCHITECT OF ANY DISCREPANCIES. IN THE CASE OF DISCREPANCIES THE ARCHITECT WILL ISSUE REVISIONS IN WRITING WITHIN SEVEN CALENDAR DAYS.
- ALL DIMENSIONS ARE FROM THE FACE OF FRAMING, CMU OR CONCRETE UNLESS OTHERWISE NOTED.

WALL TYPE KEY (SEE SHEET A-1.1)

3	WALL TYPE
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ROOM FINISH KEY

W2, W1, W3	BASE FINISH	W1	INDICATES ALL WALLS
F1, F2, F3, F4, F5	FLOOR FINISH		
WALL FINISHES			

ROOM FINISH SCHEDULE

WALLS	FLOOR
W1	F1
W2	F2
W3	F3
BASE	
B1	F4
B2	F5
B3	F6
FLOOR	
F1	F7
F2	F8
F3	F9
F4	F10
F5	F11

NOTE: EXTEND WALL SYSTEM TO UNDERSIDE OF CORRUGATED METAL DECK ABOVE. STUFF DECK FLUTES W/ MINERAL WOOL WITH MIN. 4 PCF DENSITY COMPRESSED 80%. COPE ALL LAYERS OF GWB TO UNDERSIDE PROFILE OF CORRUGATED METAL DECK. LEAVE 1/4" TO 1/2" JOINT AND FILL WITH FIRE SEALANT.

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SAS PROJECT NUMBER: 0627

PROJECT

HINESBURG TOWN GARAGE

HINESBURG, VT 05461

DATE: OCTOBER 14, 2016
 SCALE: AS NOTED
 DRAWN BY: SAL
 CHECKED: SHS

REVISIONS

SCHEMATIC DESIGN

FLOOR PLAN

A-1.0